

1000 Bridgeport Avenue

Suite 320 Shelton, CT 06484 (203) 712-1100





Submission

Partners, LLC

Darien, Connecticut


VERIFY SCALE BAR IS 1 INCH ON ORIGINAL DRAWING IF NOT ONE INCH ON THIS SHEET, ADJUST

5	8-30-2018	TOWN REVIEW COMMENTS V
3	8-13-2018	TOWN REVIEW COMMENTS III
2	8-3-2018	TOWN REVIEW COMMENTS II
1	7-11-2018	TOWN COMMENTS
1ARK	DATE	DESCRIPTION
DDOJECT NO:		POEOO OS

5/25/2018 FILE: B0509-06-C-400-DRAN.dwg PAR EWL

DRAINAGE PLAN - 2

1'' = 40'

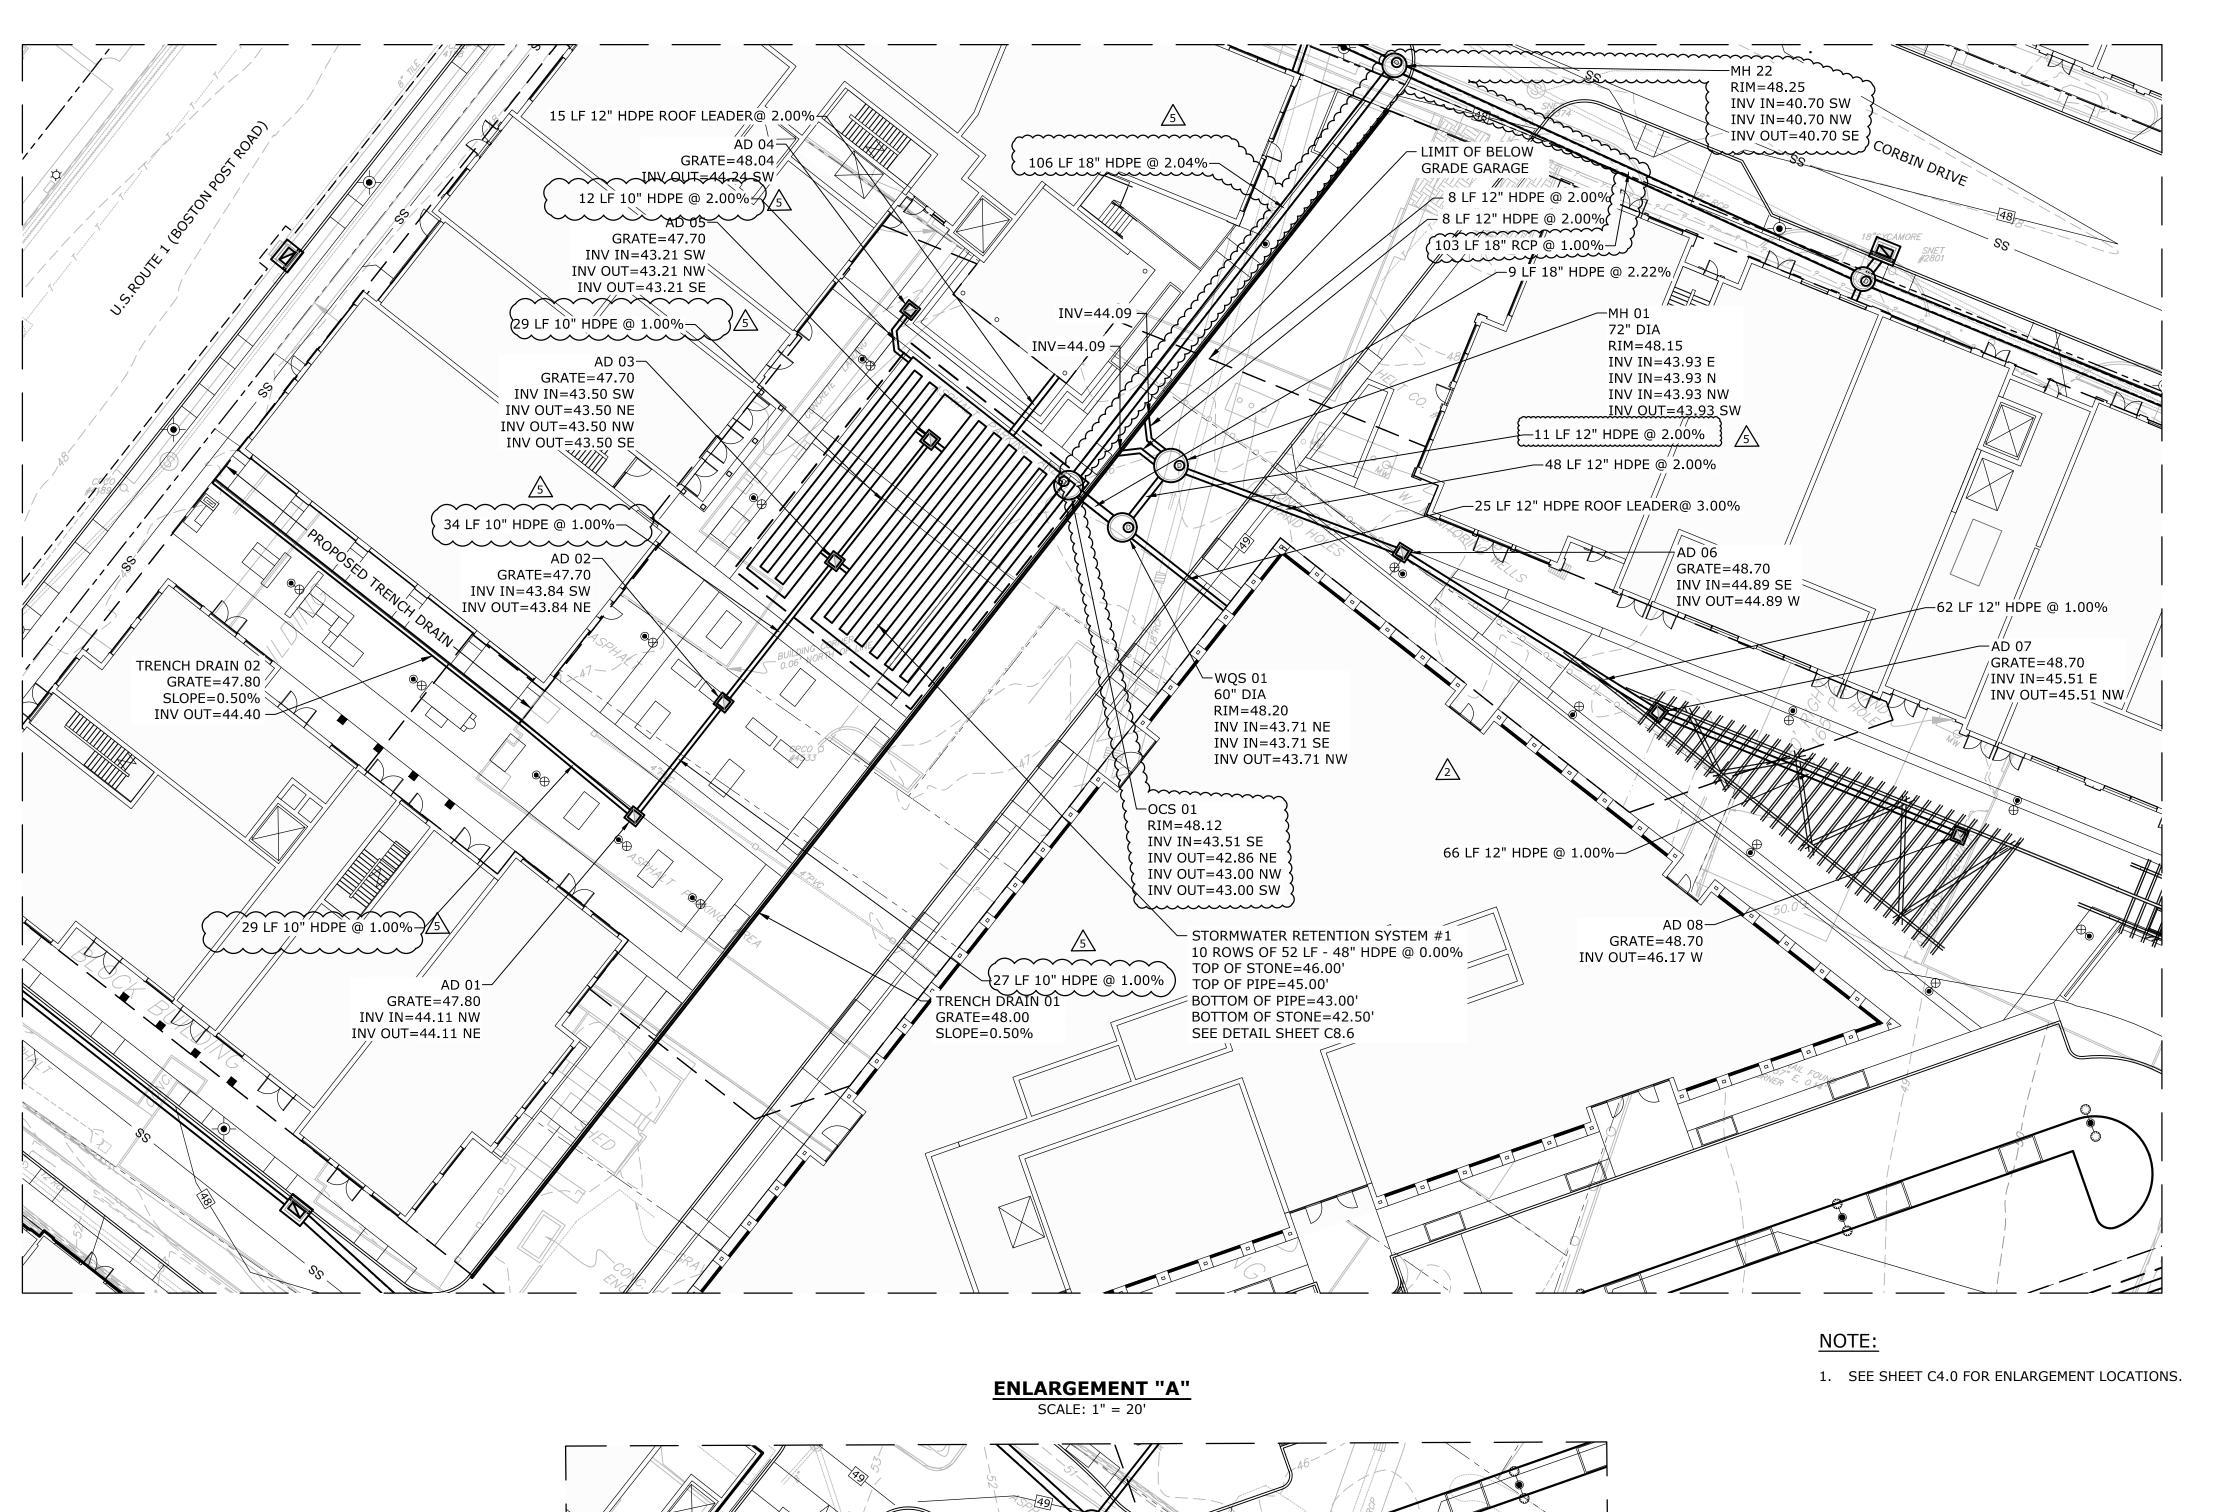

RIM=49.00 74 LF 18" HDPE @ 0.50% INV IN=42.44 NE /INV IN=42.44 NW/ INV IN=42.44 NE INV OUT=42.44 S WITH DIVERSION WEIR 4 LF 24" HDPE @ 0.50% RIM=48.40 (SEE DETAIL SHEET C8.3): INV IN=42.04 W/ INV OUT=42.04 N INV OUT=40.85 E 60" DIA RIM=48.30 INV IN=42.05 S INV IN=42.05 W INV OUT=42.05 E MH 04— 60" DIA RIM=48.19 // INV IN=42.07 N INV IN=42.07 SW INV OUT=42.57 E -3 LF 24" HDPE @ 0.50% 1 LF 12" HDPE @ 1.00% 4 LF 24" HDPE @ 12.98%— INV OUT=42.07 S

ENLARGEMENT "B"

SCALE: 1" = 20'

DRAINAGE PLAN LEGEND


WATER QUALITY STRUCTURE	000
STORM SEWER	
STORM MANHOLE	©
CATCH BASIN/AREA DRAIN	
SANITARY SEWER	ss
SANITARY MANHOLE	S
MINOR CONTOUR	
MAJOR CONTOUR	00
FLOODWAY	
FLOOD ZONE "AE"	
100' UPLAND REVIEW AREA	

SCALE IN FEET
0 20' 40'
GRAPHIC SCALE

Tighe&Bond
www.tighebond.com
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Shelton, CT 06484

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NO. 2750

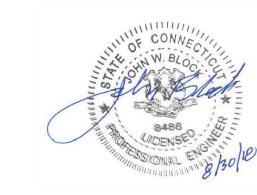

Town
Submission

Baywater Corbin Partners, LLC

Corbin Block

Darien, Connecticut

DERIFY SCALE

BAR IS 1 INCH ON
ORIGINAL DRAWING

1 INCH
IF NOT ONE INCH ON
THIS SHEET, ADJUST
SCALES ACCORDINGLY

5 8-30-2018 TOWN REVIEW COMMENTS No. 2 8-3-2018 TOWN REVIEW COMMENTS No. 1 7-11-2018 TOWN COMMENTS NO. 1 DESCRIPTION

MARK DATE DESCRIPTION

PROJECT NO: B0509-06

DATE: 5/25/2018

FILE: B0509-06-C-400-DRAN.dwg

DRAWN BY: MDS

CHECKED:


APPROVED:

DRAINAGE ENLARGEMENT

EWL

LE: AS NOTED

C4.2

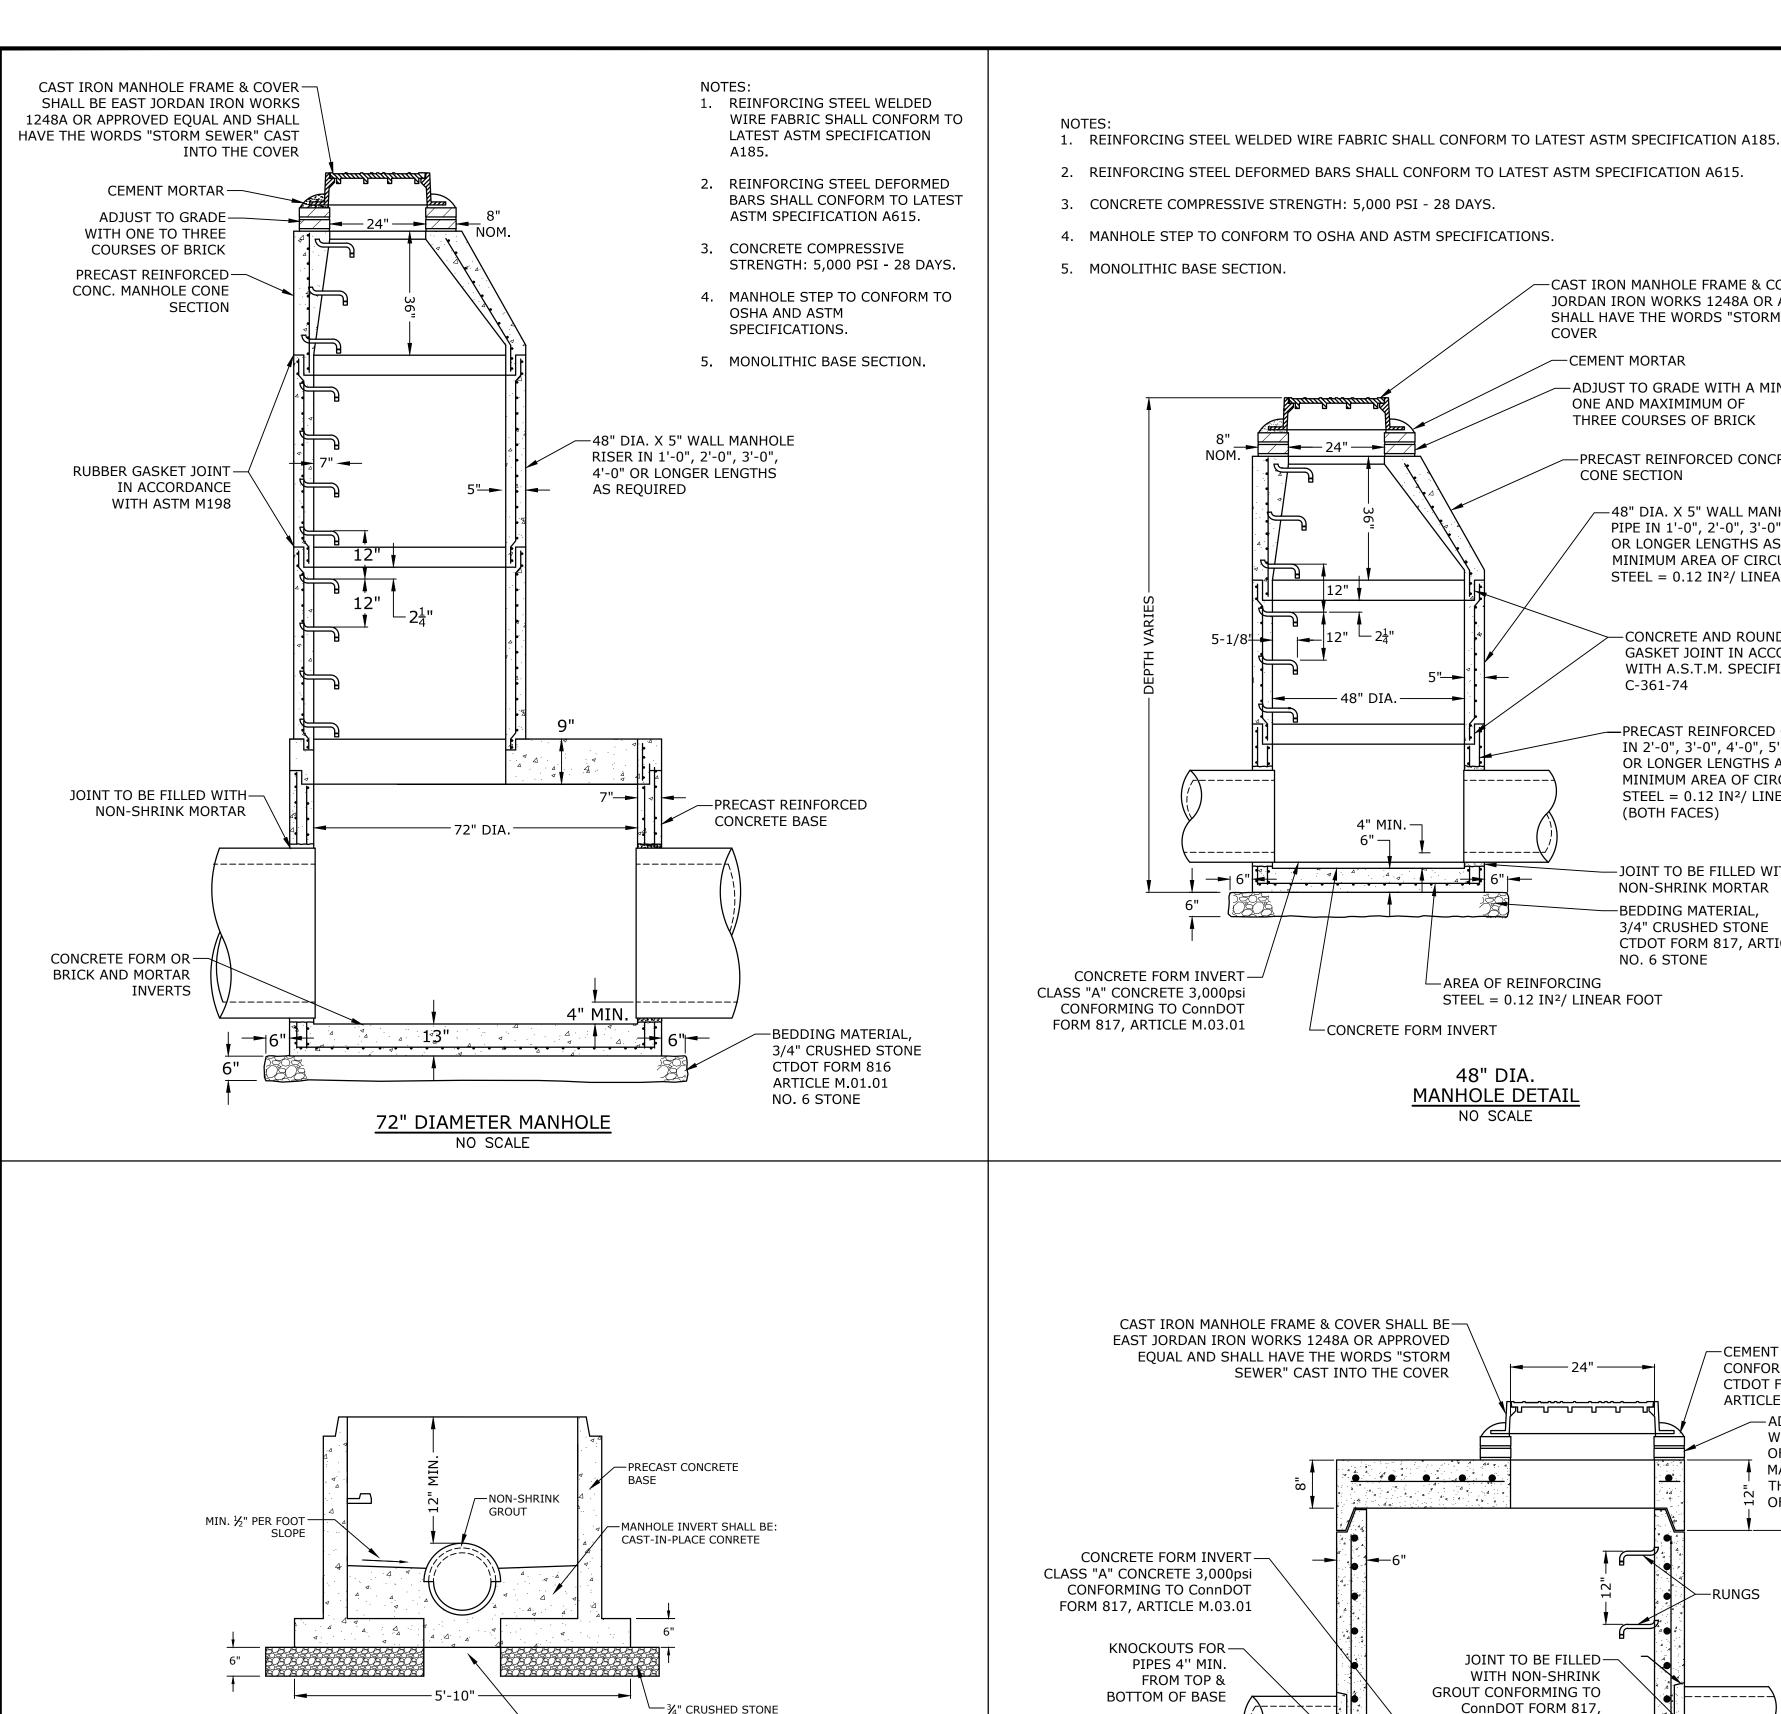

BEDDING MATERIAL

FARTH

2. DOGHOUSE OPENING MAY ONLY BE USED WHEN PLACING A NEW MANHOLE OVER AN

EXISTING MAIN TO BE NEATLY CUT ALONG THE SPRING LINE OF THE PIPE.

5. SEE STORM MANHOLE DETAIL FOR ADDITIONAL INFORMATION.

3. OPENINGS IN PRECAST UNITS ARE TO BE 4" MINIMUM TO 8" MAXIMUM LARGER THAN THE

4. TOP HALF OF EXISTING PIPE TO BE REMOVED FOR FULL LENGTH EXPOSED INSIDE MANHOLE.

STORM DRAINAGE

DOGHOUSE MANHOLE BASE


EXISTING LINE; OTHERWISE, THE OPENING MUST BE CAST. SIZE, LOCATION AND ANGLE OF


NOTES:

1. MINIMUM 4' DIAMETER MANHOLE.

ENTRY SHOULD BE AS REQUIRED BY THE PLANS.


OUTSIDE DIAMETER OF THE EXISTING PIPE.

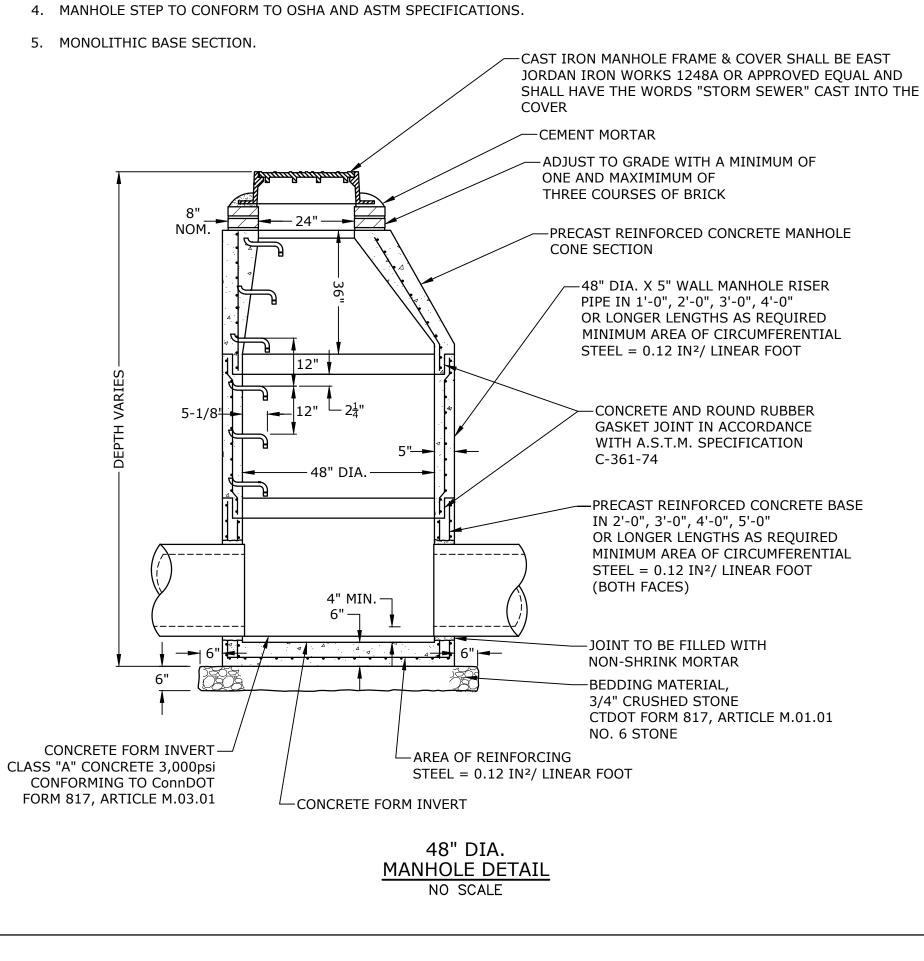

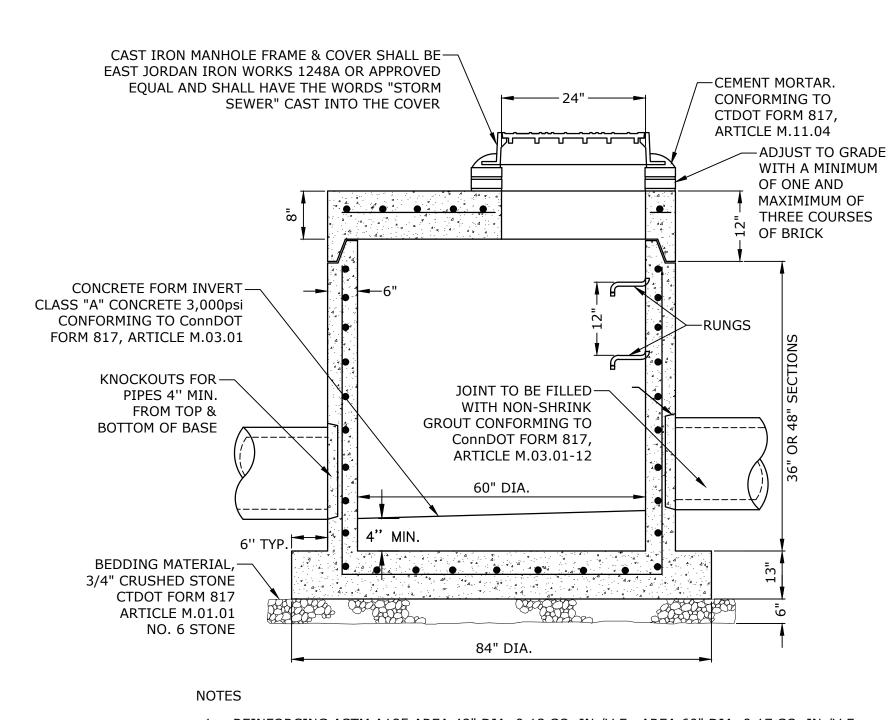

1. REINFORCING ASTM A185 AREA 48" DIA. 0.12 SQ. IN./V.F., AREA 60" DIA. 0.17 SQ. IN./V.F. REINFORCE BELL & SPIGOT. 2. CONCRETE COMPRESSIVE STRENGTH: 5,000 psi - 28 DAYS MANHOLE STEP TO CONFORM TO OSHA AND ASTM SPECIFICATIONS. 4. MONOLITHIC BASE SECTION.


60" DIA. FLAT TOP MANHOLE

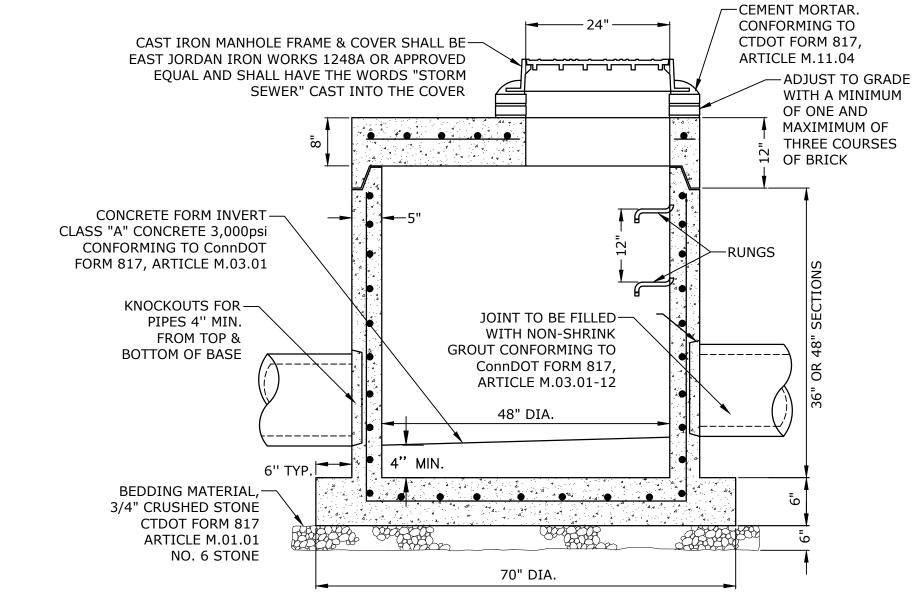


NOTES

- 1. REINFORCING ASTM A185 AREA 48" DIA. 0.12 SQ. IN./V.F., AREA 60" DIA. 0.17 SQ. IN./V.F.
- REINFORCE BELL & SPIGOT.
- 2. CONCRETE COMPRESSIVE STRENGTH: 5,000 psi 28 DAYS 3. MANHOLE STEP TO CONFORM TO OSHA AND ASTM SPECIFICATIONS.
- 4. MONOLITHIC BASE SECTION.

48" DIA. FLAT TOP MANHOLE NO SCALE

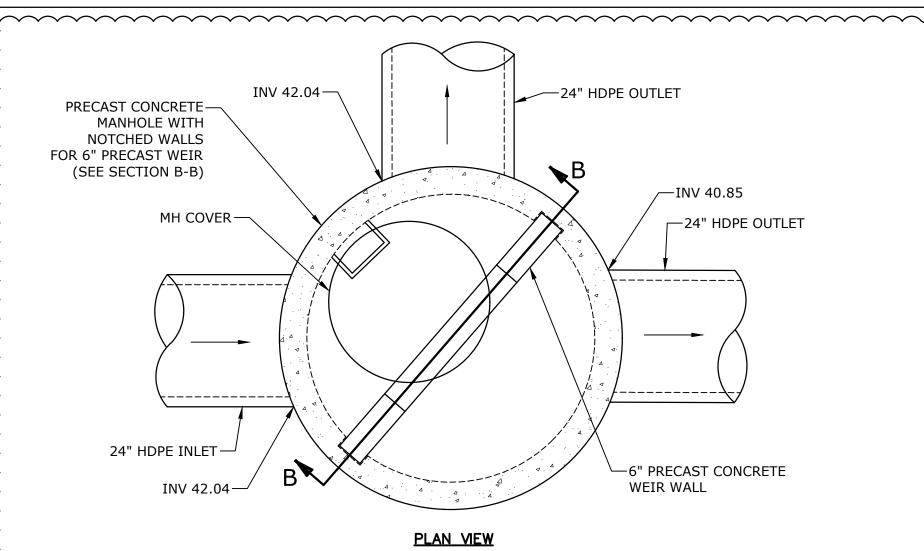

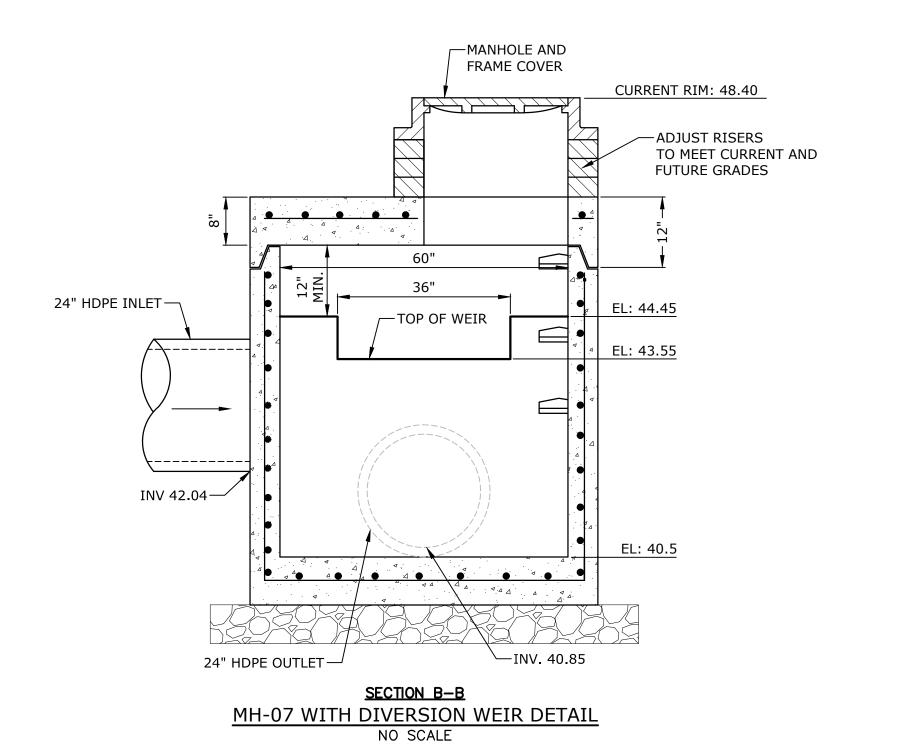

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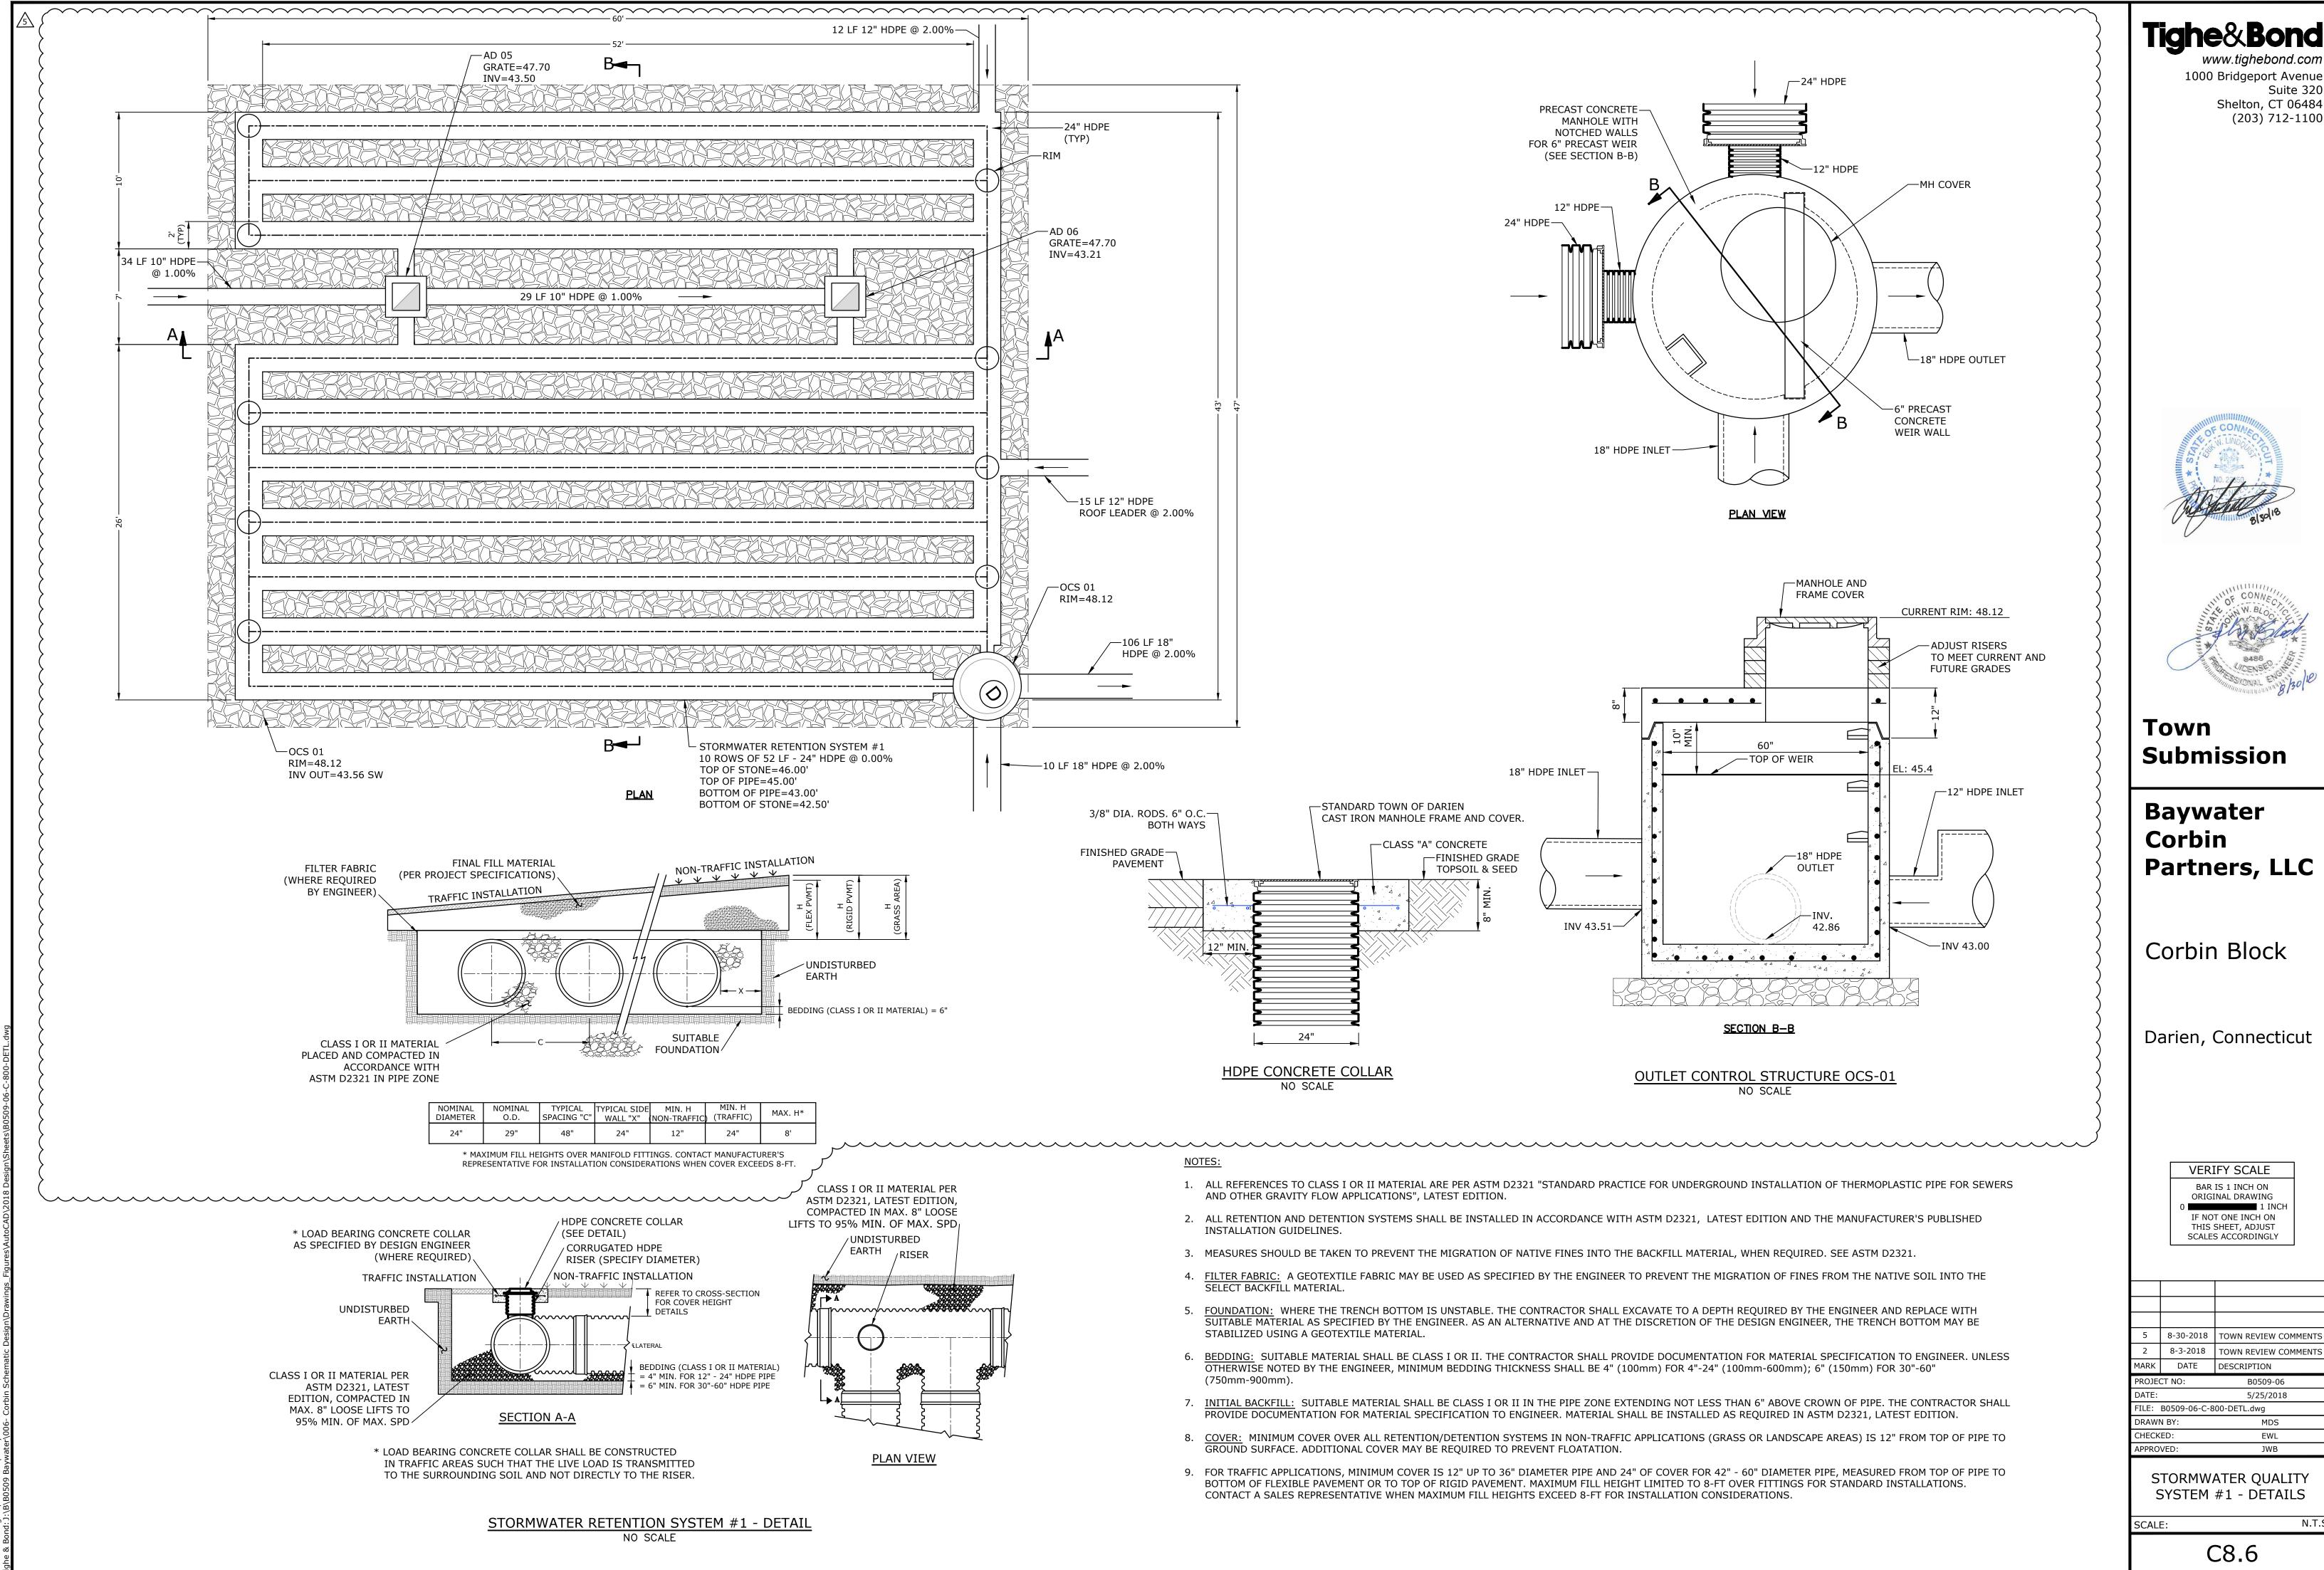
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:		5/25/2018

MARK PROJE DATE: FILE: B0509-06-C-800-DETL.dwg DRAWN BY: MDS CHECKED: EWL APPROVED: JWB


STORM DETAILS - 2


N.T.S C8.3





	8-30-2018	TOWN REVIEW COMMENTS V
	8-3-2018	TOWN REVIEW COMMENTS II
K	DATE	DESCRIPTION

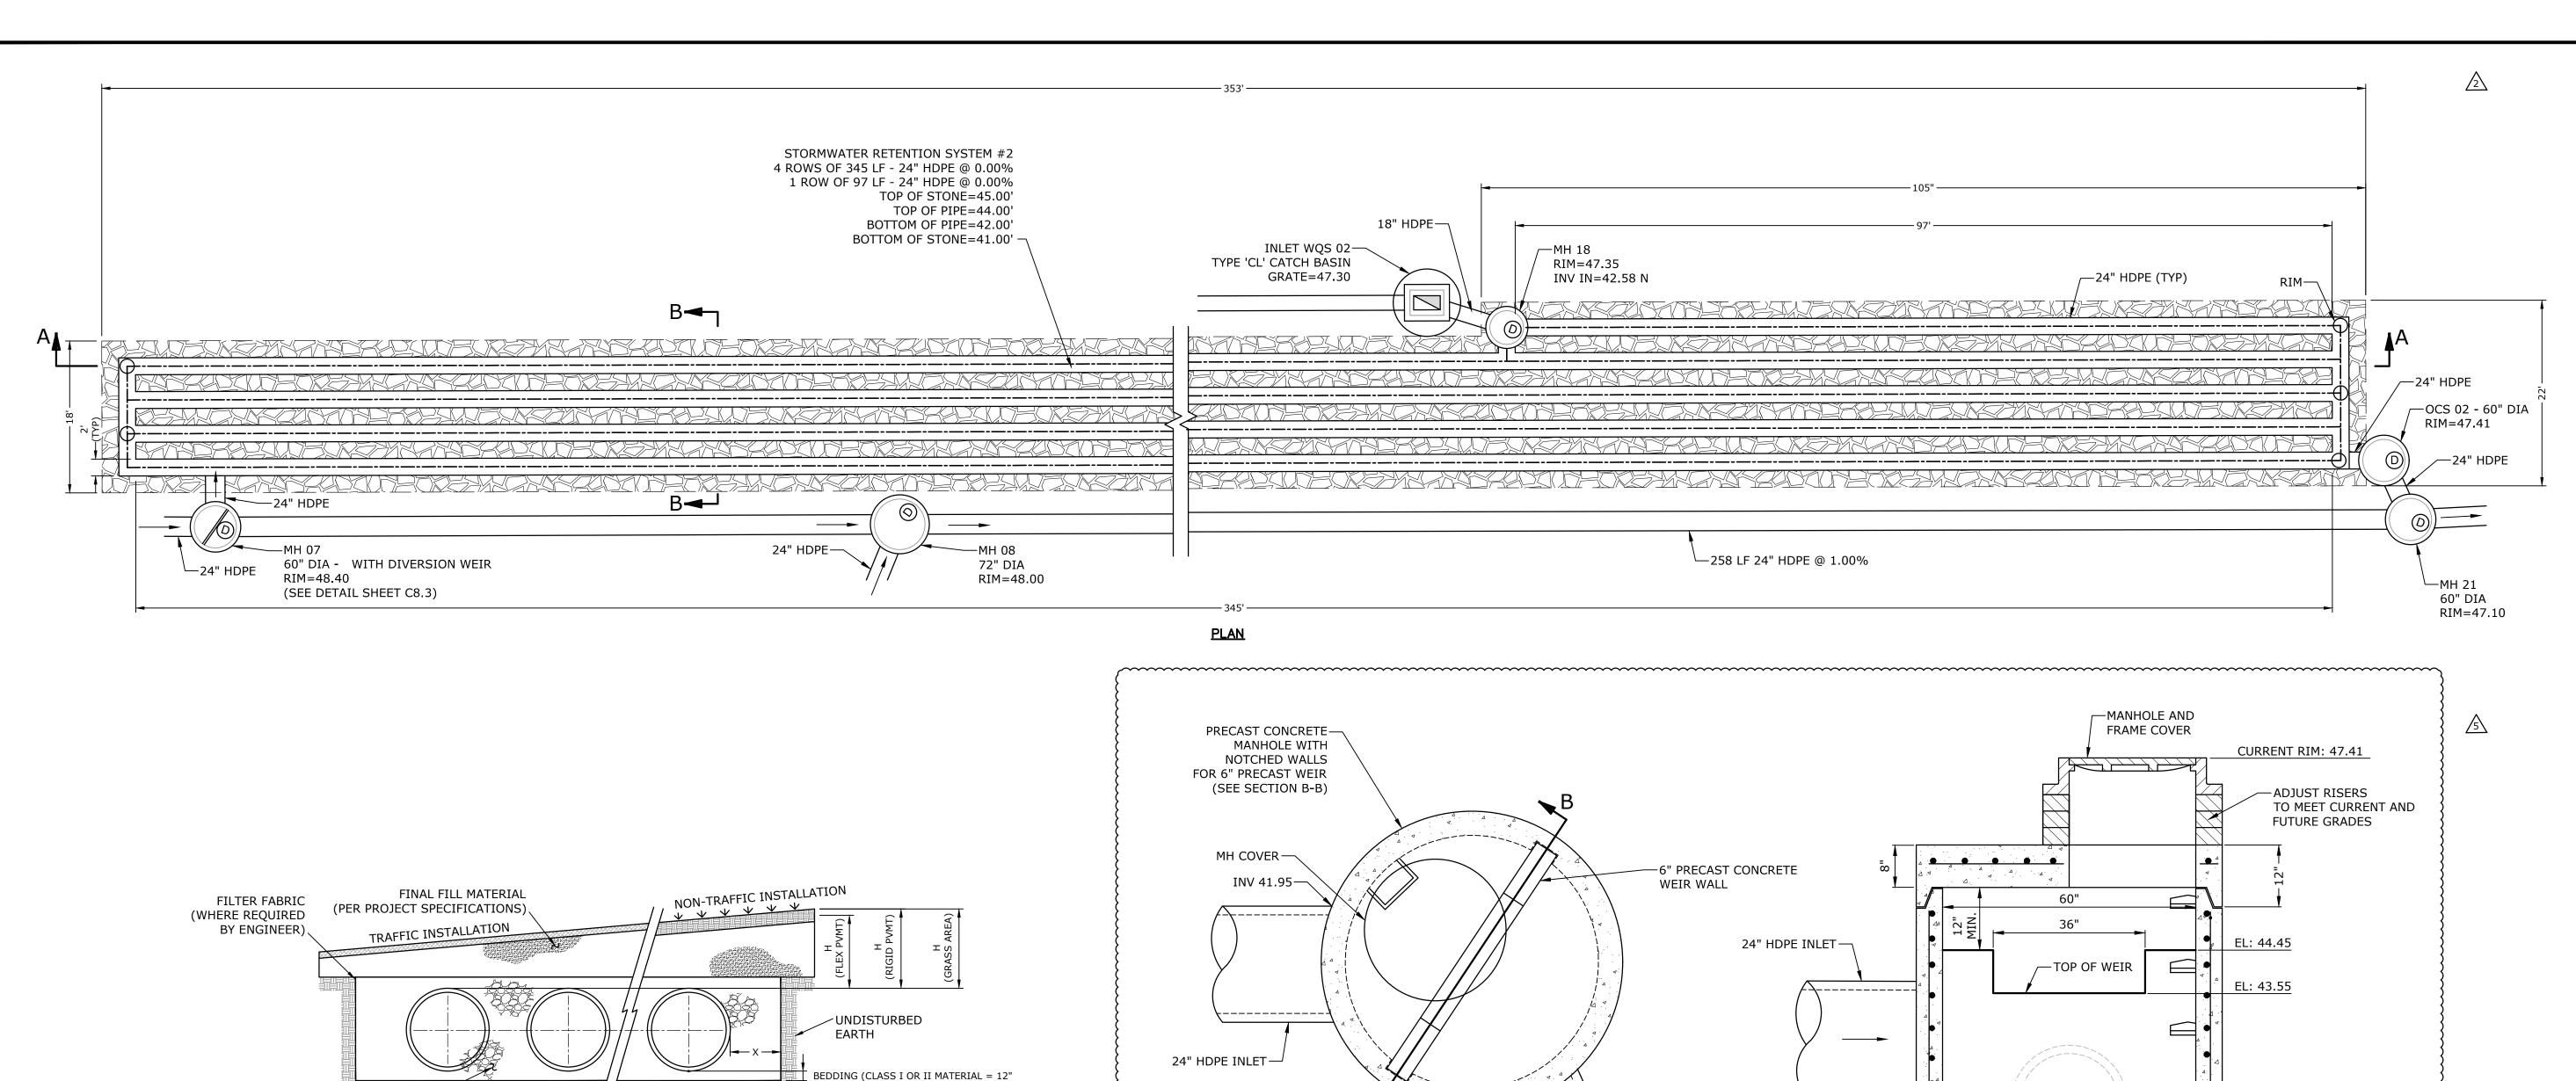

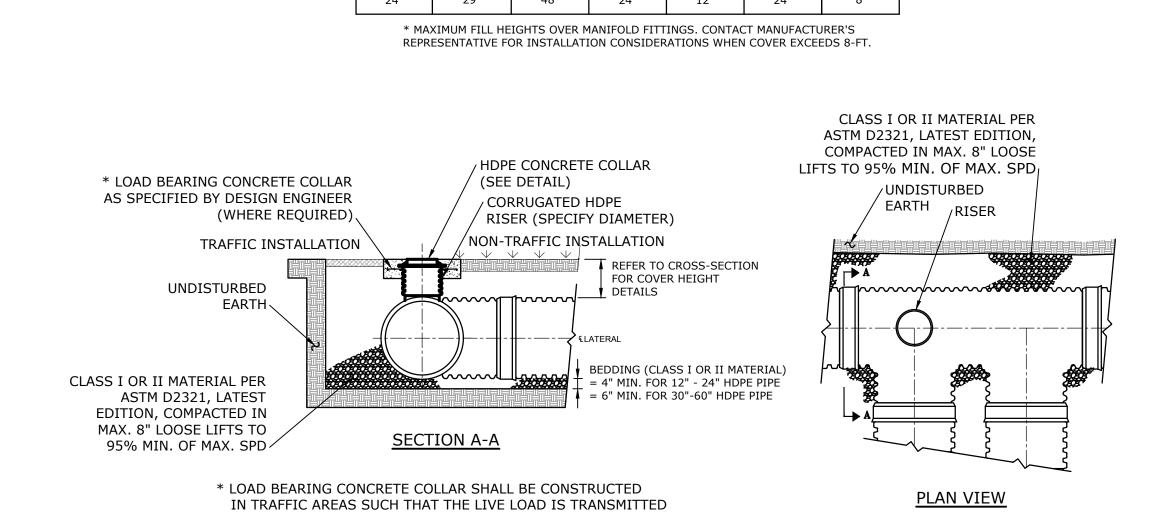

CLASS I OR II MATERIAL

ACCORDANCE WITH

PLACED AND COMPACTED IN

ASTM D2321 IN PIPE ZONE

SUITABLE

MAX. H*

(TRAFFIC)

FOUNDATION /

TYPICAL TYPICAL SIDE MIN. H MIN. H SPACING "C" WALL "X" (NON-TRAFFIC) (TRAFFIC)

STORMWATER RETENTION SYSTEM #2 - DETAIL NO SCALE

TO THE SURROUNDING SOIL AND NOT DIRECTLY TO THE RISER.

OUTLET CONTROL STRUCTURE OCS-02

NO SCALE

INV 41.95-

24" HDPE OUTLET-

WHEN REQUIRED. SEE ASTM D2321.

1. ALL REFERENCES TO CLASS I OR II MATERIAL ARE PER ASTM D2321 "STANDARD PRACTICE FOR UNDERGROUND INSTALLATION OF THERMOPLASTIC PIPE FOR SEWERS AND OTHER GRAVITY FLOW APPLICATIONS", LATEST EDITION.

SECTION B-B

2. ALL RETENTION AND DETENTION SYSTEMS SHALL BE INSTALLED IN ACCORDANCE WITH ASTM D2321, LATEST EDITION AND THE MANUFACTURER'S PUBLISHED INSTALLATION GUIDELINES.

· 4.4 4 . . 4 . . 4 . .

—INV. 40.85

EL: 40.5


- 3. MEASURES SHOULD BE TAKEN TO PREVENT THE MIGRATION OF NATIVE FINES INTO THE BACKFILL MATERIAL,
- 4. FILTER FABRIC: A GEOTEXTILE FABRIC MAY BE USED AS SPECIFIED BY THE ENGINEER TO PREVENT THE MIGRATION OF FINES FROM THE NATIVE SOIL INTO THE SELECT BACKFILL MATERIAL.
- 5. <u>FOUNDATION:</u> WHERE THE TRENCH BOTTOM IS UNSTABLE. THE CONTRACTOR SHALL EXCAVATE TO A DEPTH REQUIRED BY THE ENGINEER AND REPLACE WITH SUITABLE MATERIAL AS SPECIFIED BY THE ENGINEER. AS AN ALTERNATIVE AND AT THE DISCRETION OF THE DESIGN ENGINEER, THE TRENCH BOTTOM MAY BE STABILIZED USING A GEOTEXTILE MATERIAL.
- 6. <u>BEDDING:</u> SUITABLE MATERIAL SHALL BE CLASS I OR II. THE CONTRACTOR SHALL PROVIDE DOCUMENTATION FOR MATERIAL SPECIFICATION TO ENGINEER. UNLESS OTHERWISE NOTED BY THE ENGINEER, MINIMUM BEDDING THICKNESS SHALL BE 4" (100mm) FOR 4"-24" (100mm-600mm); 6" (150mm) FOR 30"-60" (750mm-900mm).
- 7. <u>INITIAL BACKFILL:</u> SUITABLE MATERIAL SHALL BE CLASS I OR II IN THE PIPE ZONE EXTENDING NOT LESS THAN 6" ABOVE CROWN OF PIPE. THE CONTRACTOR SHALL PROVIDE DOCUMENTATION FOR MATERIAL SPECIFICATION TO ENGINEER. MATERIAL SHALL BE INSTALLED AS REQUIRED IN ASTM D2321, LATEST EDITION.
- 8. <u>COVER:</u> MINIMUM COVER OVER ALL RETENTION/DETENTION SYSTEMS IN NON-TRAFFIC APPLICATIONS (GRASS OR LANDSCAPE AREAS) IS 12" FROM TOP OF PIPE TO GROUND SURFACE. ADDITIONAL COVER MAY BE REQUIRED TO PREVENT FLOATATION.
- 9. FOR TRAFFIC APPLICATIONS, MINIMUM COVER IS 12" UP TO 36" DIAMETER PIPE AND 24" OF COVER FOR 42" 60" DIAMETER PIPE, MEASURED FROM TOP OF PIPE TO BOTTOM OF FLEXIBLE PAVEMENT OR TO TOP OF RIGID PAVEMENT. MAXIMUM FILL HEIGHT LIMITED TO 8-FT OVER FITTINGS FOR STANDARD INSTALLATIONS. CONTACT A SALES REPRESENTATIVE WHEN MAXIMUM FILL HEIGHTS EXCEED 8-FT FOR INSTALLATION CONSIDERATIONS.

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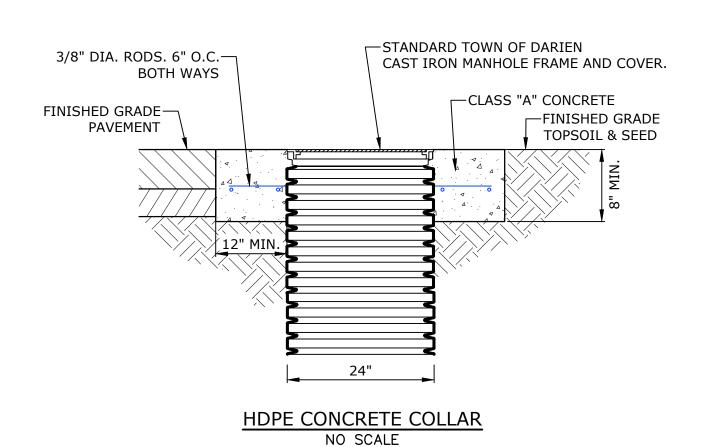
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STORMWATER QUALITY SYSTEM #2 - DETAILS


C8.7





INV 40.85-

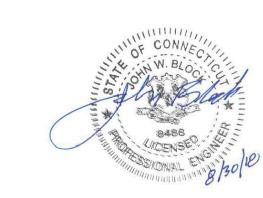24" HDPE OUTLET


PLAN VIEW

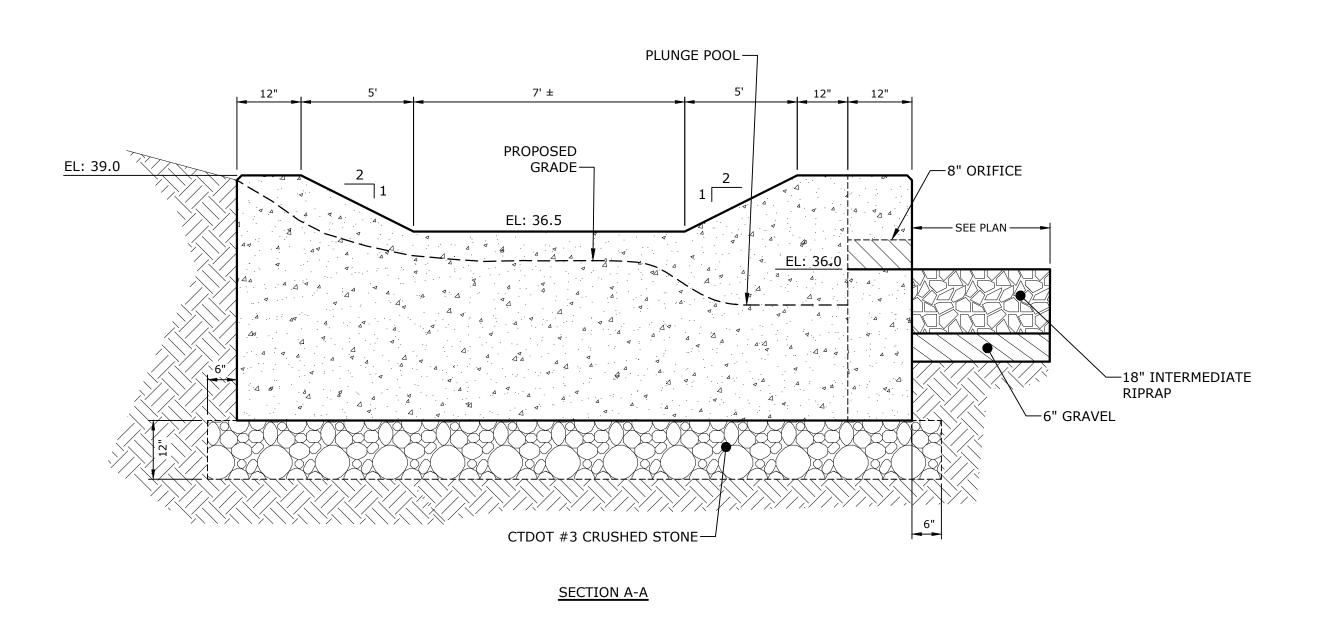

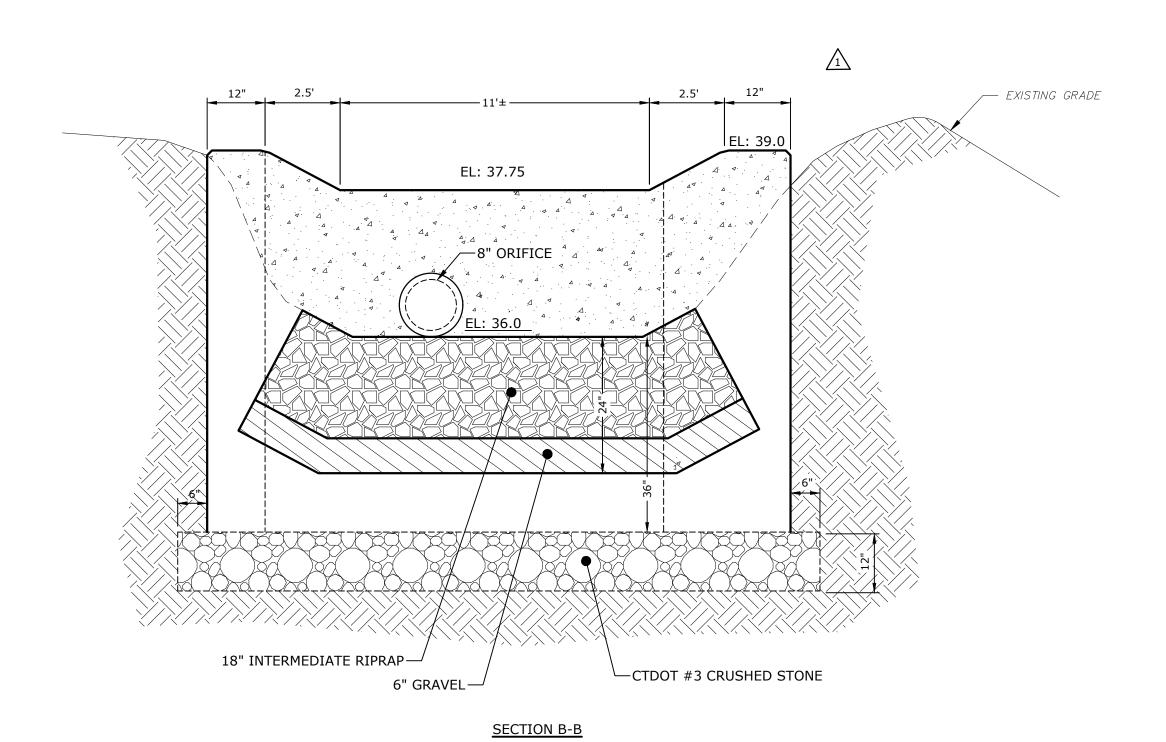

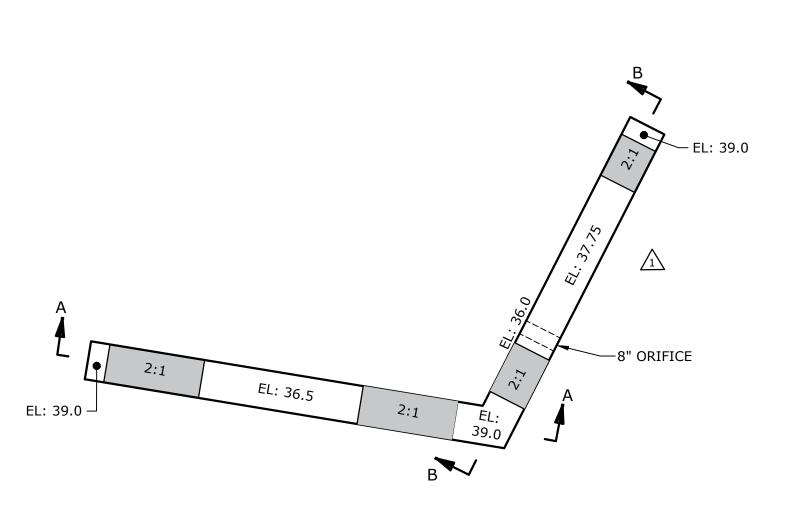

DIVERSION WALL - DETAIL
NO SCALE

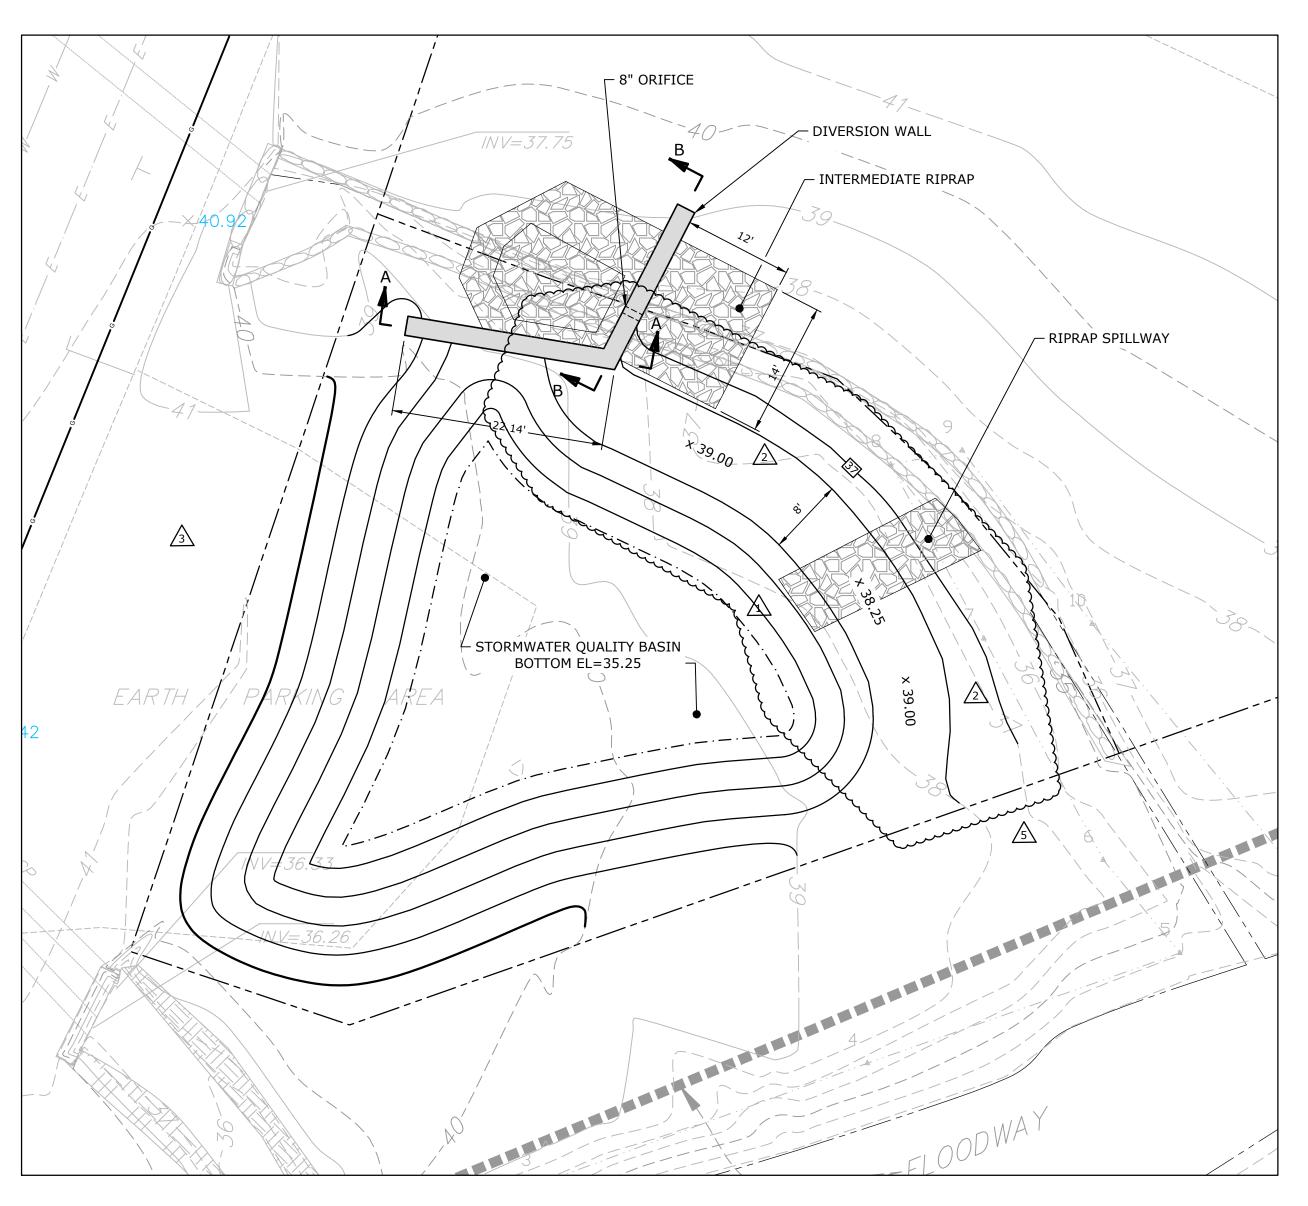

NOTE:
1. FINAL DETAILS OF DIVERSION WALL TO BE COORDINATED DURING THE CONSTRUCTION DOCUMENTS PHASE.

STORMWATER QUALITY BASIN DETAIL

SCALE: 1" = 10'


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DRAWN BY: MDS

CHECKED: EWL

WATER QUALITY BASIN DETAILS

SCALE:

APPROVED:

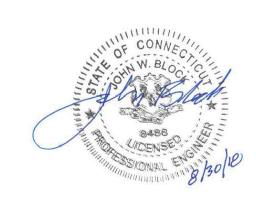C8.9

st Saved: 8/30/2018 tted On: Aug 30, 2018-1:47pm By: sansonem ine & Bond: 1:\R\B0509 Bavwater\006- Corbin So